

TOTAL PRESS. AIR REQUIRED = 4480 CFM TOTAL PRESS. AIR PROVIDED = 4480 CFM

SMOKE CONTROL NOTES:

THE EXISTING BUILDING IS PROVIDED WITH AN SMOKE CONTROL SYSTEM THROUGH OUT.

2. REFER TO ELECTRICAL PLANS FOR SMOKE DETECTOR LOCATIONS.

TYP. HEAT PUMP COOLING MODE SEQUENCE OF OPERATION

1. THE DAMPER POSITIONS FOR TYP. HEAT PUMP IN

1. THE DAMPER POSITIONS FOR TYP. HEAT PUMP IN COOLING MODE ARE AS FOLLOWS:

A. MOTORIZED DAMPER ON SUPPLY AIR DUCT SHALL OPEN.
B. MOTORIZED DAMPER ON OUTSIDE AIR DUCT SHALL OPEN.
C. MOTORIZED DAMPER ON PRESSURIZATION AIR DUCT SHAL BE CLOSED.

2. OUTSIDE AIR DAMPER FOR TYP. HEAT PUMP SHALL BE PROGRAMMED TO CLOSE DURING UNOCCUPIED HOURS.

3. HEAT PUMPS FAN AND COMPRESSOR SHALL START AND STOP CONTROLLED BY SPACE THERMOSTATS.

SMOKE CONTROL SEQUENCE OF OPERATION

1. THE SMOKE CONTROL SYSTEM SHALL INITIATE WITHIN 30 SECONDS.

2. THIS SPACE SHALL OPERATE IN SMOKE CONTROL MODE AS DESIGNED BY THE SHELL BUILDING SMOKE CONTROL PANEL.

3. SMOKE DETECTOR ROOM & FIRE FLOW SENSORS SHALL INITIATE SMOKE CONTROL MODE.

4. A CALL FOR PRESSURIZATION IN THIS ZONE SHALL INITIATE:

1. THE SEQUENCE FOR TYP. HEAT PUMP WHEN ZONE IS IN

PRESSURIZATION:

A. MOTORIZED DAMPER ON SUPPLY AIR DUCT SHALL CLOSE.
B. MOTORIZED DAMPER ON OUTSIDE AIR DUCT SHALL CLOSE.
C. MOTORIZED DAMPER ON PRESSURIZATION AIR DUCT SHALL OPEN.
D. HEAT PUMP TO SHUTDOWN.

E. EXISTING SMOKE SUPPLY FAN SHALL START.

5. A CALL FOR SMOKE EXHAUST IN THIS ZONE SHALL INITIATE:

1. THE SEQUENCE FOR TYP, HEAT PUMP WHEN ZONE IS IN

A. MOTORIZED DAMPER ON SUPPLY AIR DUCT SHALL CLOSE.
B. MOTORIZED DAMPER ON OUTSIDE AIR DUCT SHALL CLOSE.
C. MOTORIZED DAMPER ON PRESSURIZATION AIR DUCT SHALL OPEN.
D. HEAT PUMP TO SHUTDOWN.
E. COMBINATION EXH. DAMPER SHALL OPEN.
F. EXISTING SMOKE EXHAUST SHALL START. EXISTING SMOKE SUPPLY SHALL START.

## SMOKE TEST PROCEDURE:

- 1. SMOKE BOMB PLACEMENT AND SIZES SHALL BE AS SHOWN ON PLANS.
- 2. SMOKE CONTROL SYSTEM SHALL ACTIVATE WITHIN 60 SECONDS OF IGNITION OF THE SMOKE BOMBS.
- 3. WITHIN 13 MINUTES OF THE START OF THE TEST, THE EXIT SIGN MUST BE LEGIBLE FROM 20 FEET.

#### SMOKE TEST CALC'S:

#### **VOLUME 1: ELEVATOR LOBBY AND CORRIDOR**

AREA OF PROTECTION 3360 SQ.FT.

AVERAGE CEILING HEIGHT X 10 FT.

VOLUME 33,600 CU.FT.

DOUBLE VOLUME X 2

REQUIRED SMOKE 67,200 CU.FT

PROVIDE (9) 1 MIN. SMOKE BOMBS THAT PRODUCE 8,000 CUFT. OF SMOKE EACH FOR A TOTAL OF 67,200 CUFT. SMOKE BOMBS SHALL BE SUPERIOR SIGNAL 2B OR EQUAL. LOCATE WHERE SHOWN ON PLAN.

FIRE ALARM LEGEND		
SYMBOL	DESCRIPTION	
3	SMOKE DETECTOR	
•	EXIT SIGN	
▲E	FIRE MAN TELEPHONE JACK	
<b>\$</b>	DUCT SMOKE DETECTOR	
•	DUAL ACTION MANUAL PULL STATION (+48" A.F.F, U.N.D)	
	STROBE LIGHT- 75 cd- U.N.D. 80"A.F.F. TO BOTTOM OF DEVICE.	
	SPEAKER/STROBE -75 cd-1/2 WATT SPKR.,U.N.D. 80"A.F.F. TO BOTTOM OF DEVICE.	
	SPEAKER- 1/2 WATT. 80"A.F.F. TO BOTTOM OF DEVICE.	
<b>SB</b>	SMOKE BOMB, SEE PLAN FOR SIZE.	
SMOKE BOMB		
MODEL #	DURATION	VOLUME
1A	30 SEC.	4,000 CU. FT.
2B	1 MIN.	8,000 CU. FT.
W3C	3 MIN.	40,000 CU. FT.

## SMOKE TEST NOTES

## 1) CONTRACTOR'S RESPONSIBILITY:


CONTRACTOR SHALL BE RESPONSIBLE FOR THE DESIGN AND CONSTRUCTION OF SMOKE TEST SYSTEM.

## 2) COORDINATION:

WORK THESE DRAWINGS WITH ARCHITECTURAL, MECHANICAL, AND ELECTRICAL DRAWINGS FOR LOCATIONS OF EMBEDDED ITEMS.

## 3) SHOP DRAWINGS:

SMOKE TEST SHOP DRAWINGS SHALL BE SUBMITTED FOR A/E REVIEW ONLY AFTER THEY HAVE BEEN THOROUGHLY REVIEWED BY THE CONTRACTOR FOR CONSTRUCTION METHODS, DIMENSIONS AND OTHER TRADE REQUIREMENTS. THEY MUST BE STAMPED WITH THE CONTRACTOR'S APPROVAL STAMP. THE A/E ASSUMES NO RESPONSIBILITY FOR DIMENSIONS, QUANTITIES, ERRORS OR OMISSIONS AS A RESULT OF REVIEWING ANY SHOP DRAWINGS.

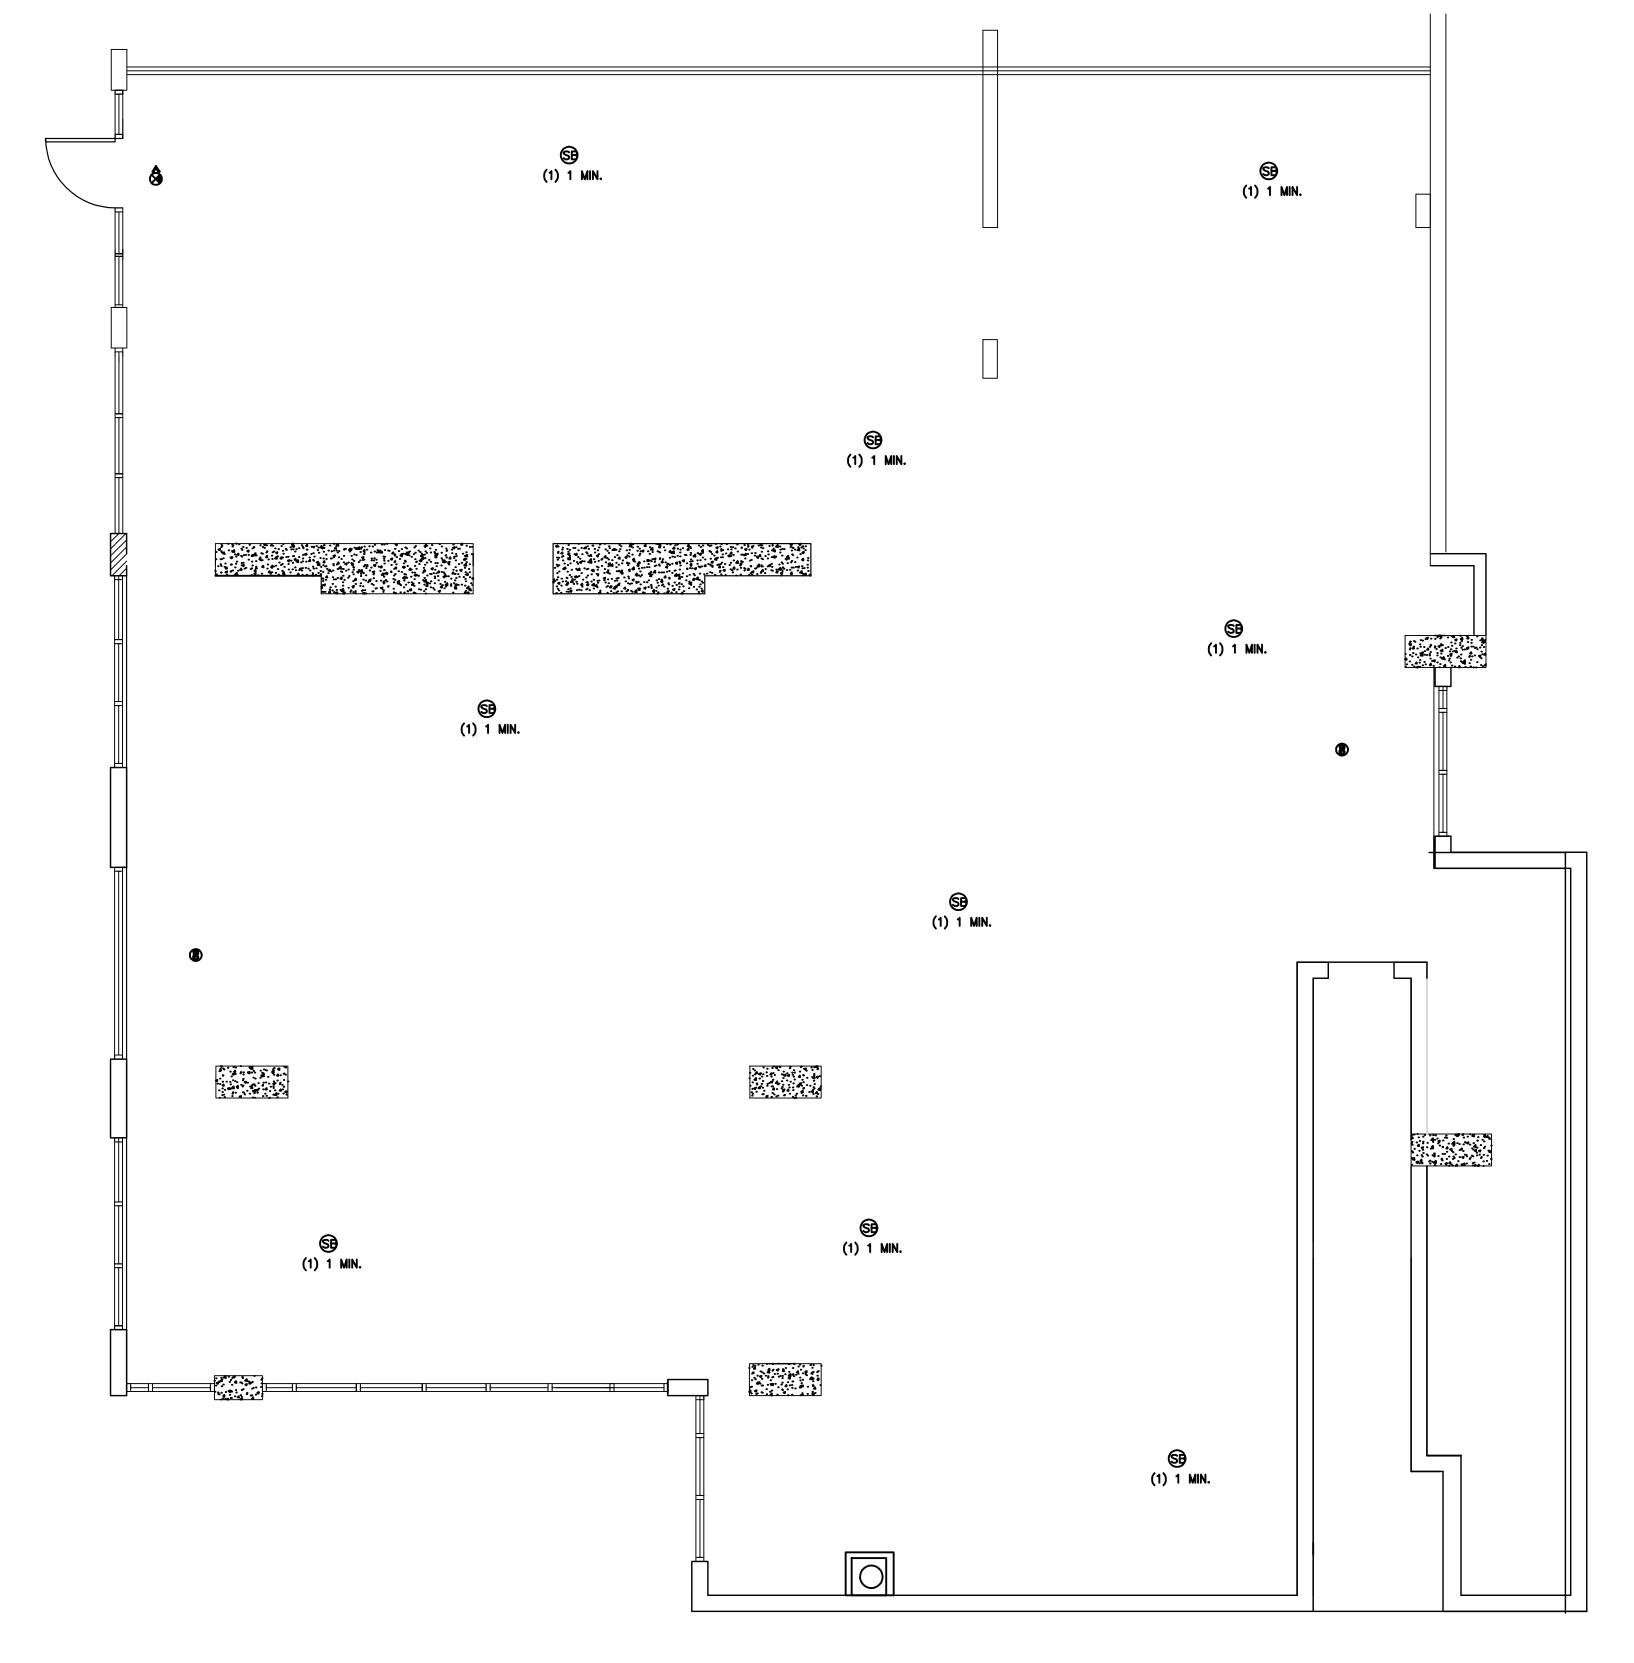

# **SMOKE TEST PLAN**

SCALE: 1/4" = 1'-0"

PSN CONSULTING, Inc. 17670 NW 78th Ave. 207 afting services by: 207 - 3301! Interior Imp 3020 NE 3 Ft.Lauderda FTC Foundo 17670 NW Palm Sprin REVISIONS: SHEET TITLE: SMOKE TEST PLAN DRAWN: CHECKED: 07.12.08 AS NOTED

JOB. NO.:

08472